



Box Beam Stiffened, Temporary Concrete Barrier

Reinforcement Details


nt Details


| 2/27/2008 | DRAWN BY:


DWG. NAME.


NY-BB-TempBarrier_R9_metric UNITS: mm

SCALE: None REV. BY: UNITS: mm KAP/RKF

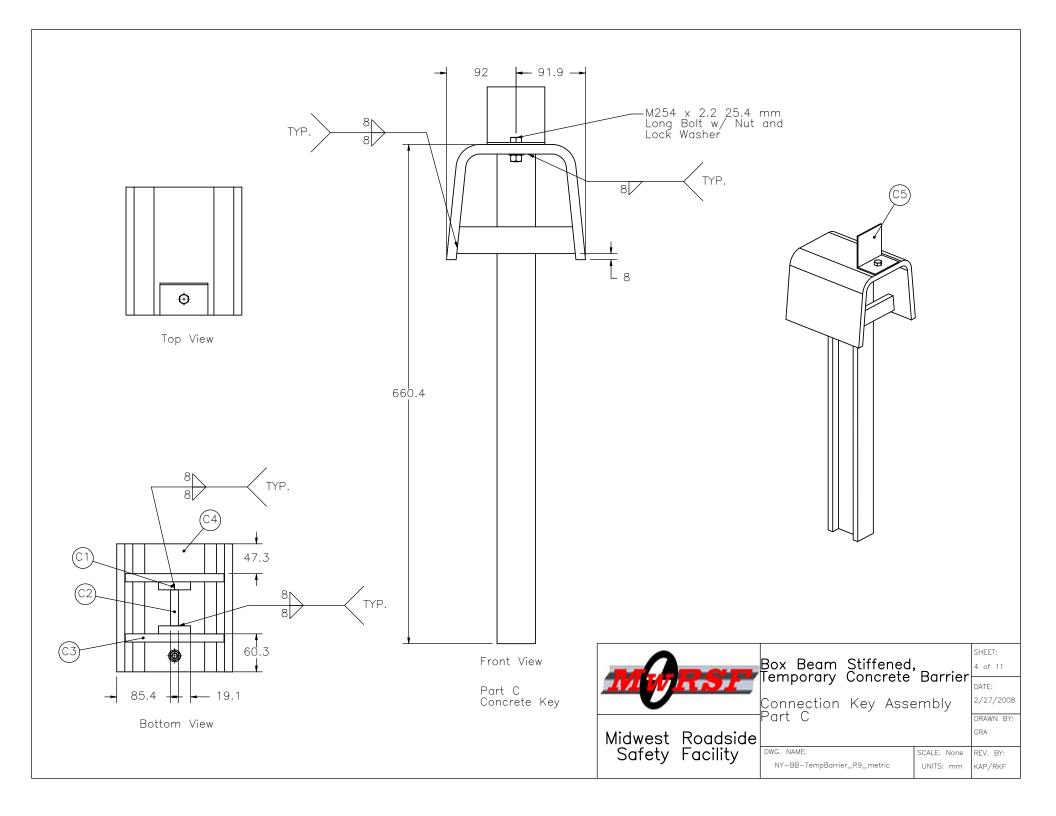

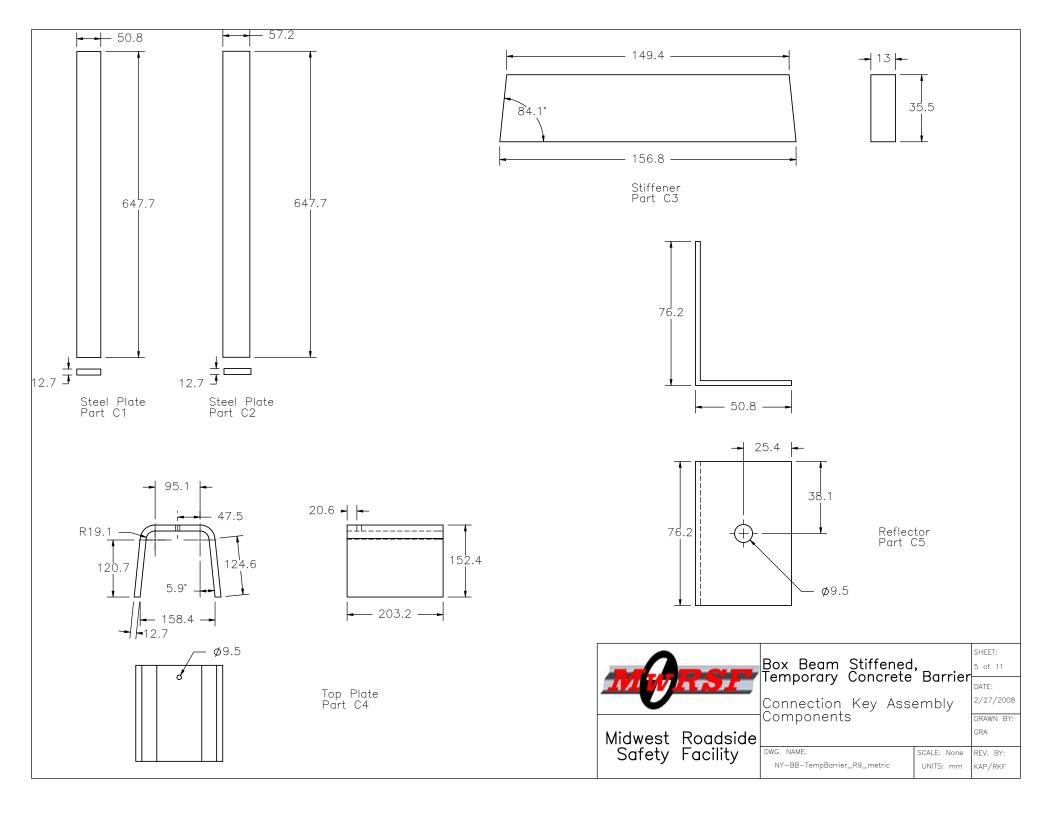


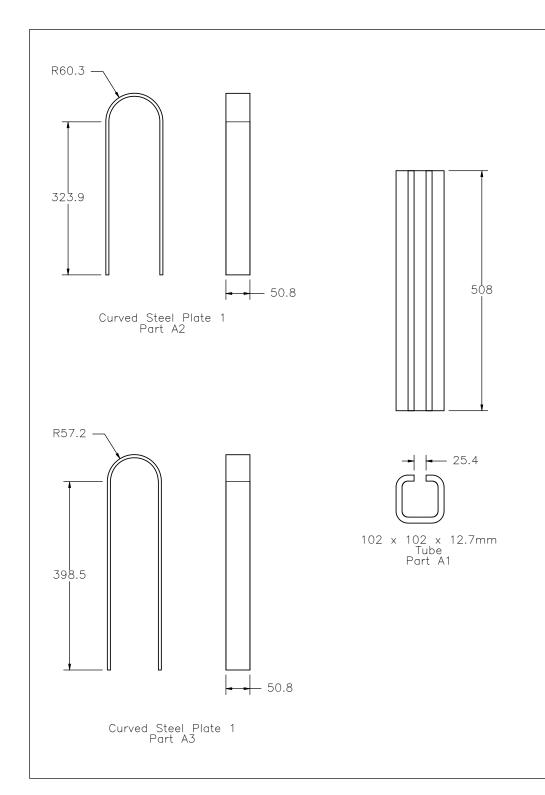

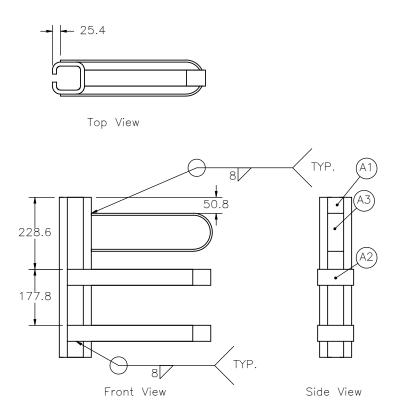







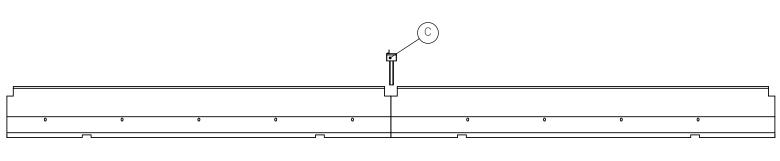

Front View

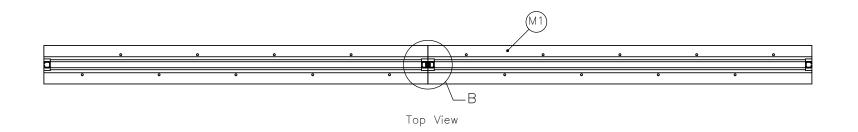

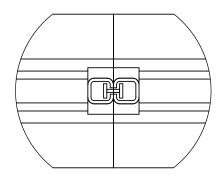

DETAIL B SCALE 1 : 15





					SHEET:
,	Вох	Beam	Stiffened,	D	7 of 11
	ıem	porary	Concrete	Barrier	DATE:

Connection Key


2/27/2008 DRAWN BY:


SCALE: None REV. BY: NY-BB-TempBarrier_R9_metric UNITS: mm KAP/RKF

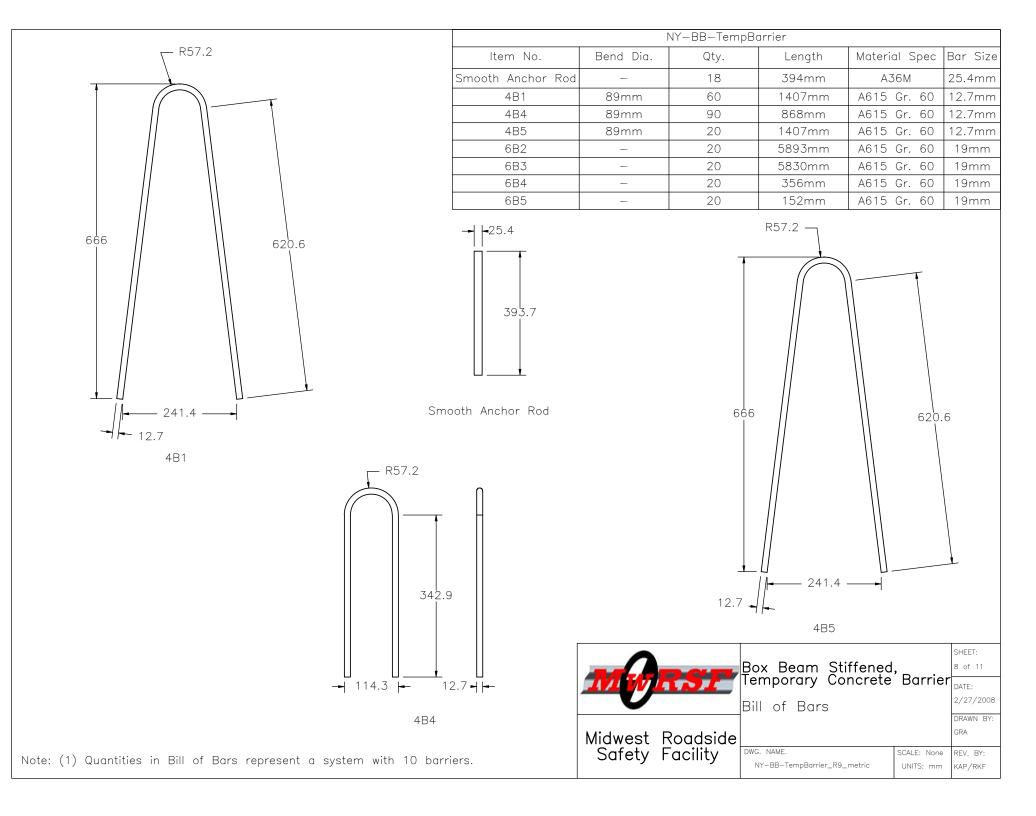

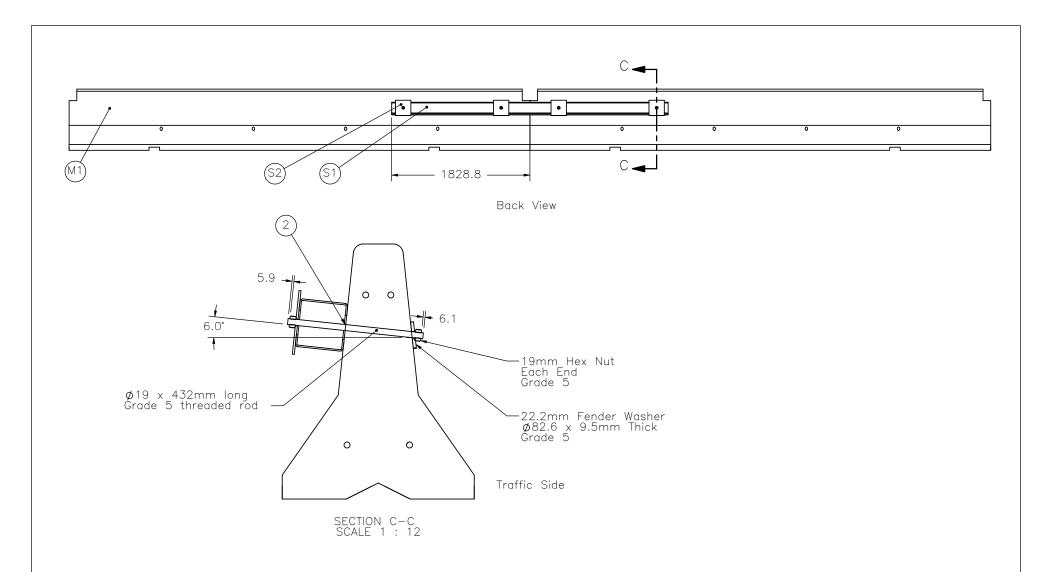



- Notes: (1) ASTM A193 Grade B7 is acceptable as a substitute for Grade 5 threaded rod.
 - (2) Shim box beam as needed with 22.2mm i.d.—82.6mm o.d. x 9.5mm thick Grade 5 washer.

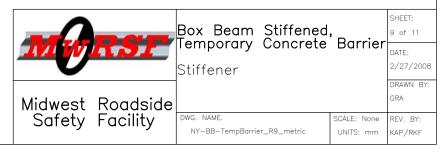


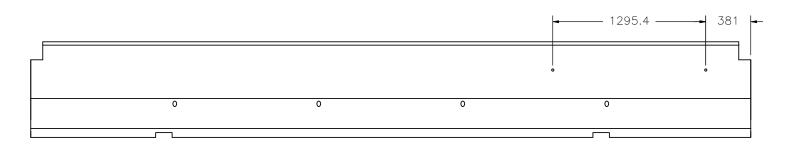


Back View

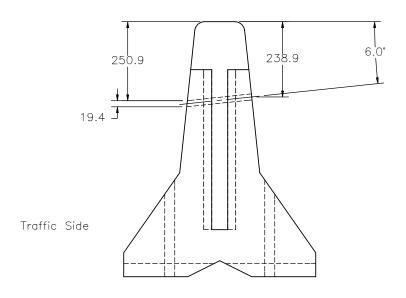

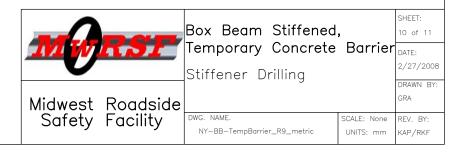

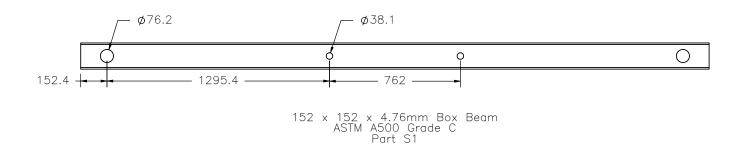

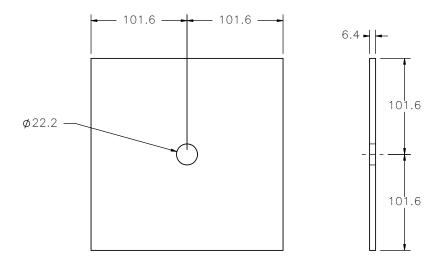

203mm Square Plate A36 Part S2

